



DO NOT SCALE FROM THIS DRAWING. USE FIGURED DIMENSIONS IN ALL CASES. VERIFY DIMENSIONS ON SITE AND REPORT ANY DISCREPANCIES TO THE DESIGNERS IMMEDIATELY. THIS DRAWING IS TO BE READ IN CONJUNCTION WITH THE DESIGNERS SPECIFICATION. © THIS DRAWING IS COPYRIGHT AND MAY ONLY BE REPRODUCED WITH THE DESIGNERS PERMISSION.

NOTES:


1. ALL DRAWINGS ARE TO BE READ IN CONJUNCTION WITH ALL RELEVANT SPECIFICATIONS, BILLS OF QUANTITIES, ARCHITECTURAL, SERVICES AND ENGINEERING DRAWINGS.
2. ALL LEVELS ARE IN METRES RELATED TO ORDNANCE DATUM MALIN HEAD.
3. ANY DISCREPANCIES BETWEEN THESE DOCUMENTS SHALL BE BROUGHT TO THE ATTENTION OF THE ENGINEER.
4. DRAWINGS ARE NOT TO BE SCALED.
5. ALL DIMENSIONS ARE IN MILLIMETRES, UNLESS NOTED OTHERWISE.

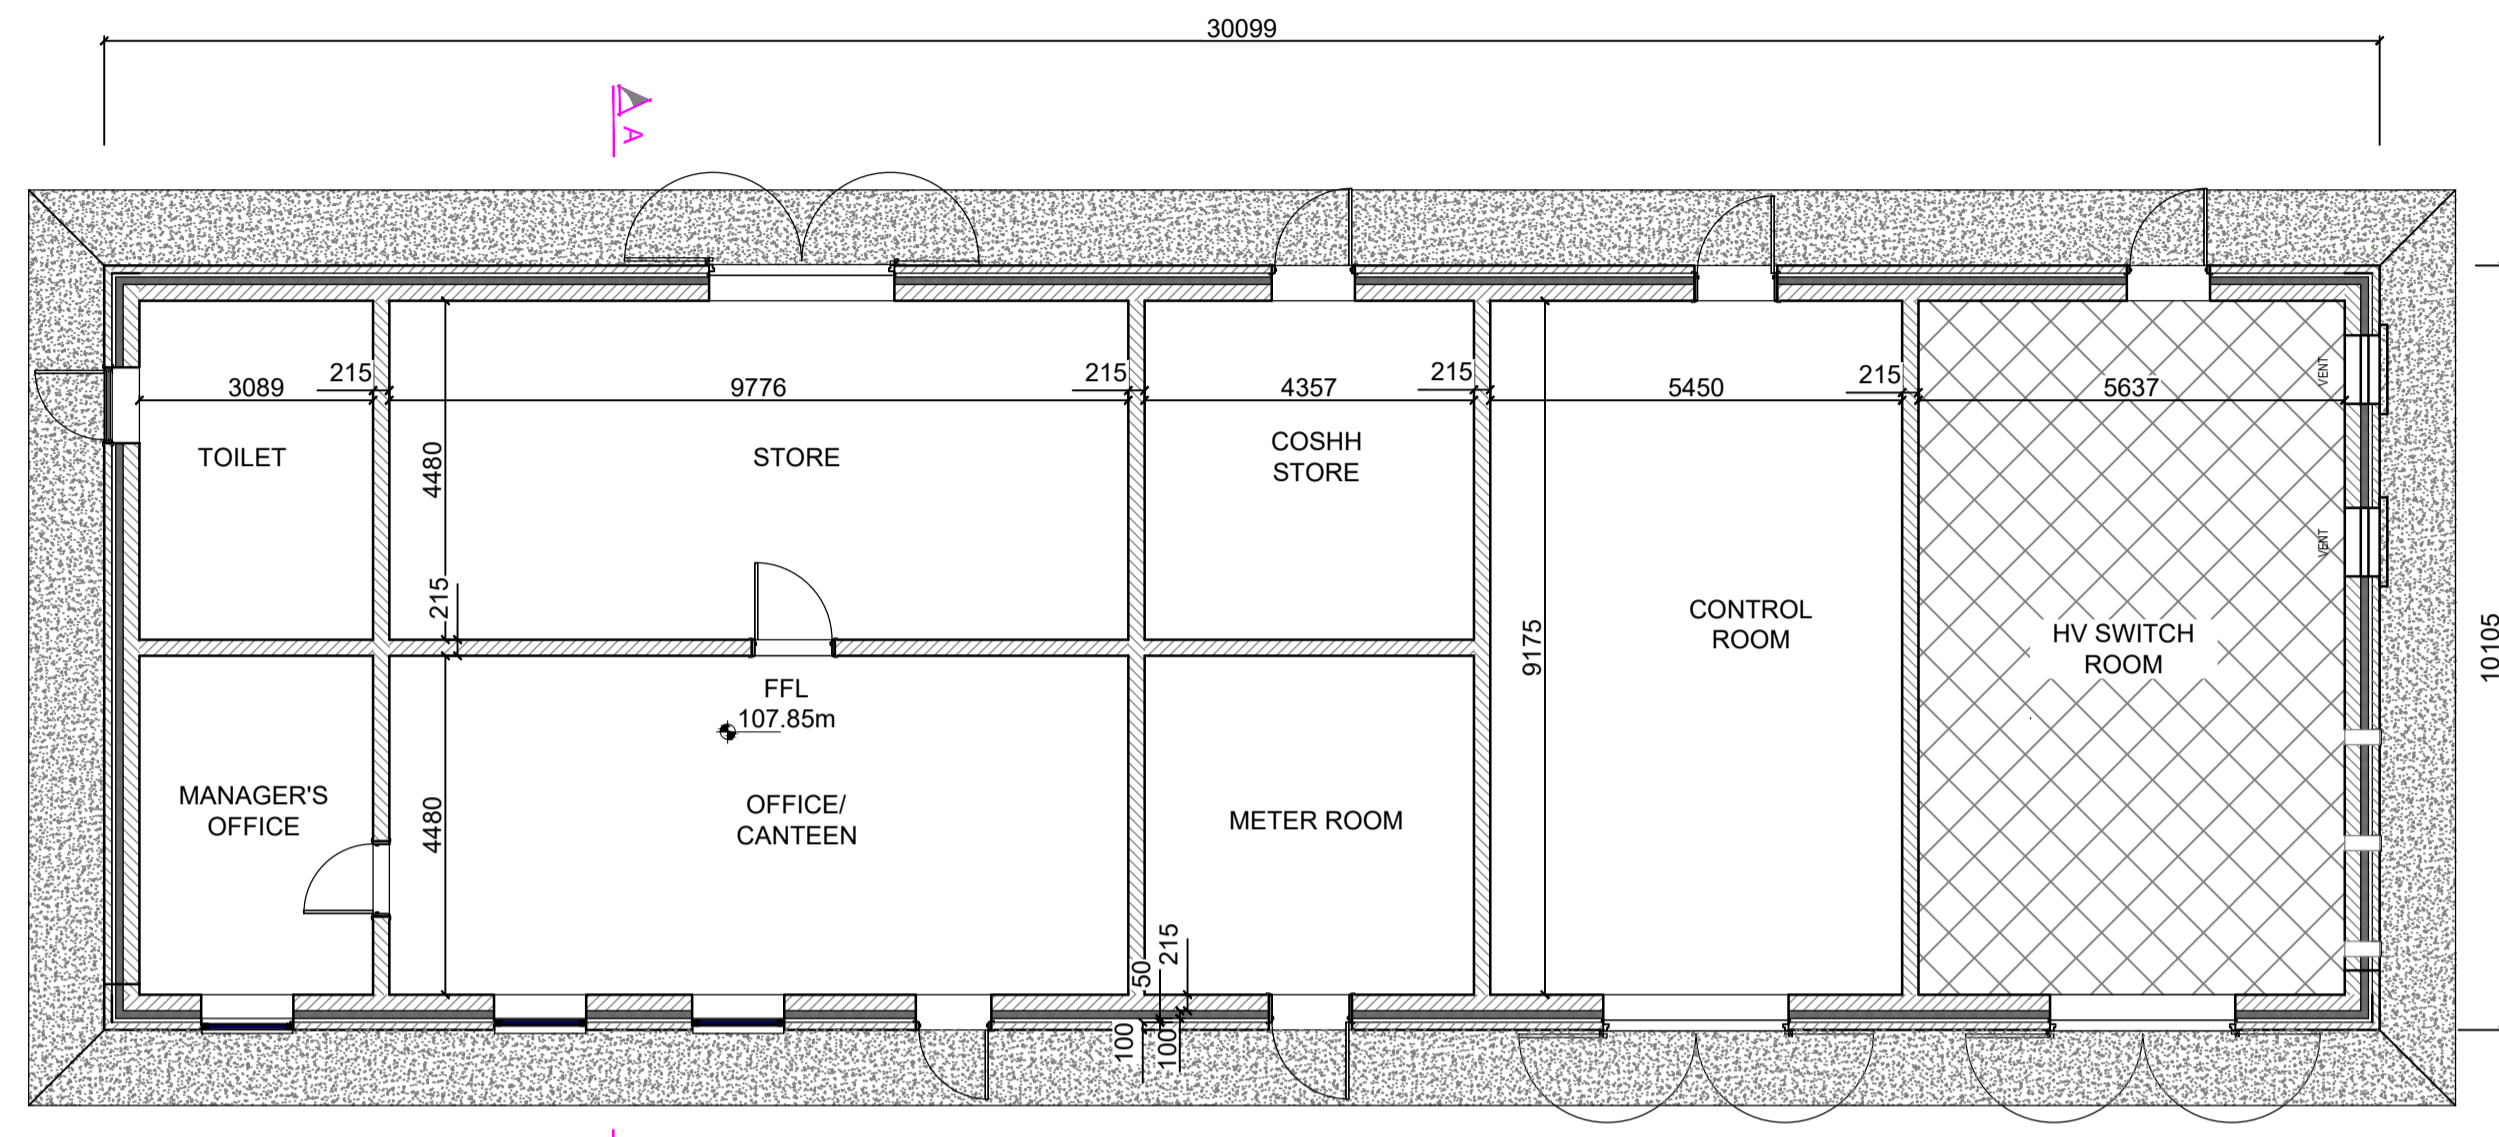


Plan Scale 1:100

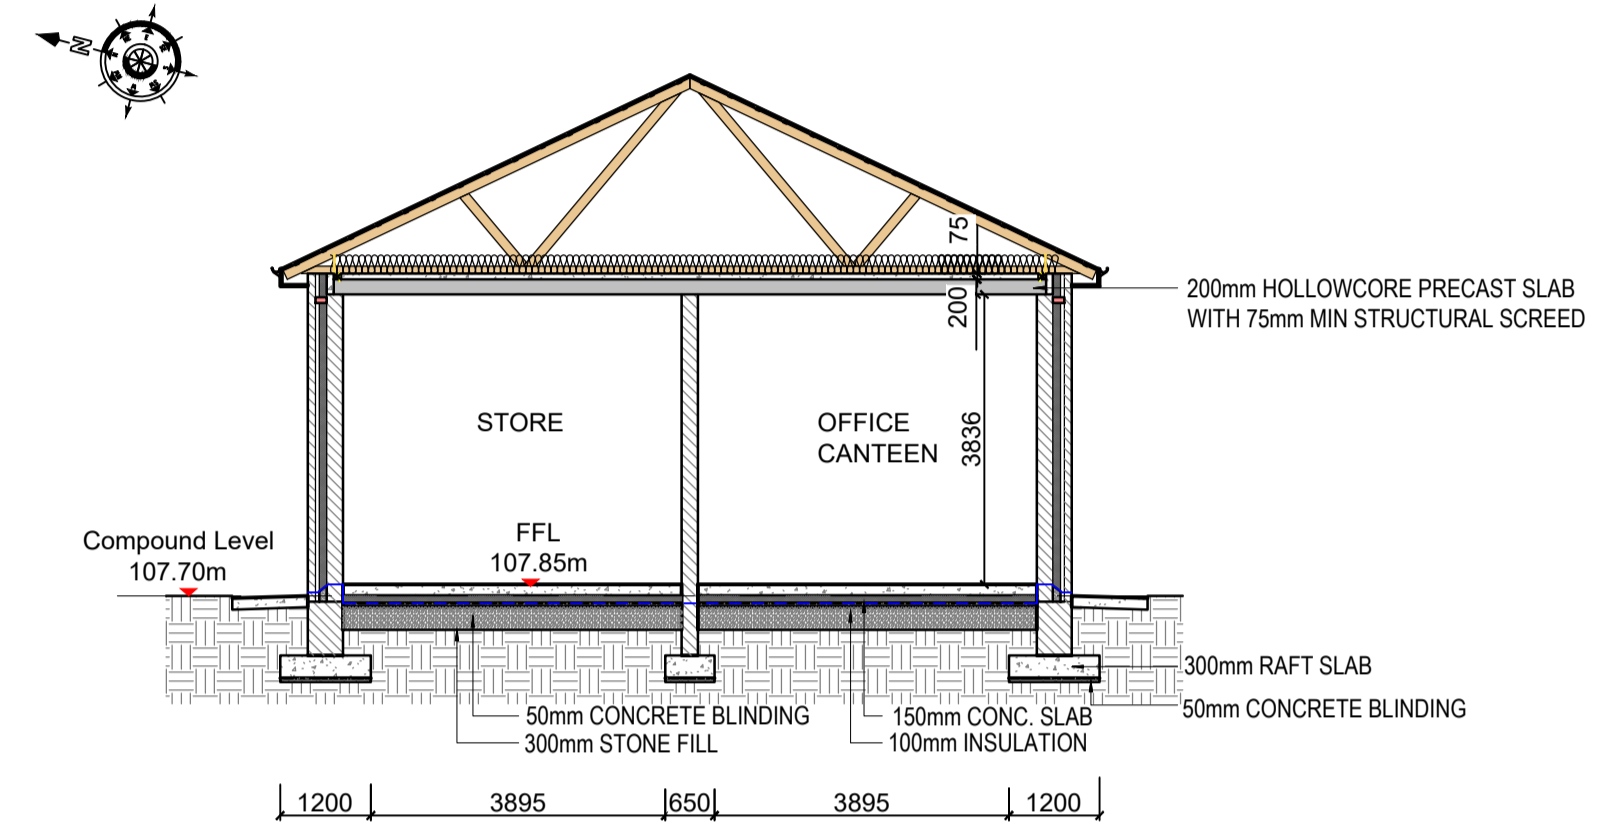


Section A-A Scale 1:100

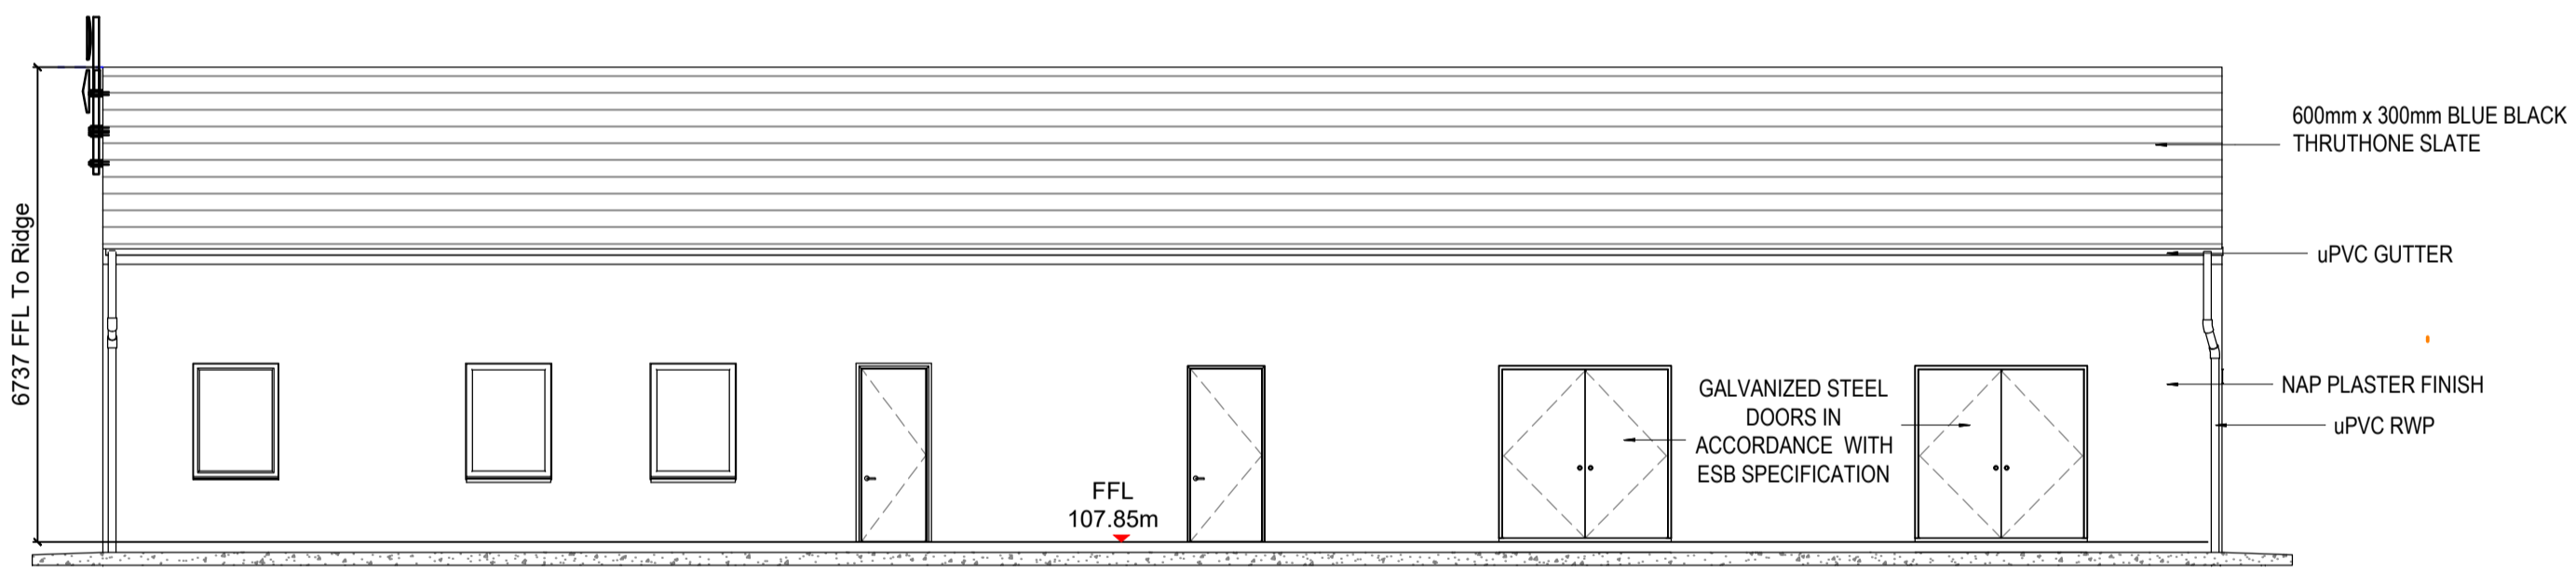


Front Elevation - West Scale 1:100

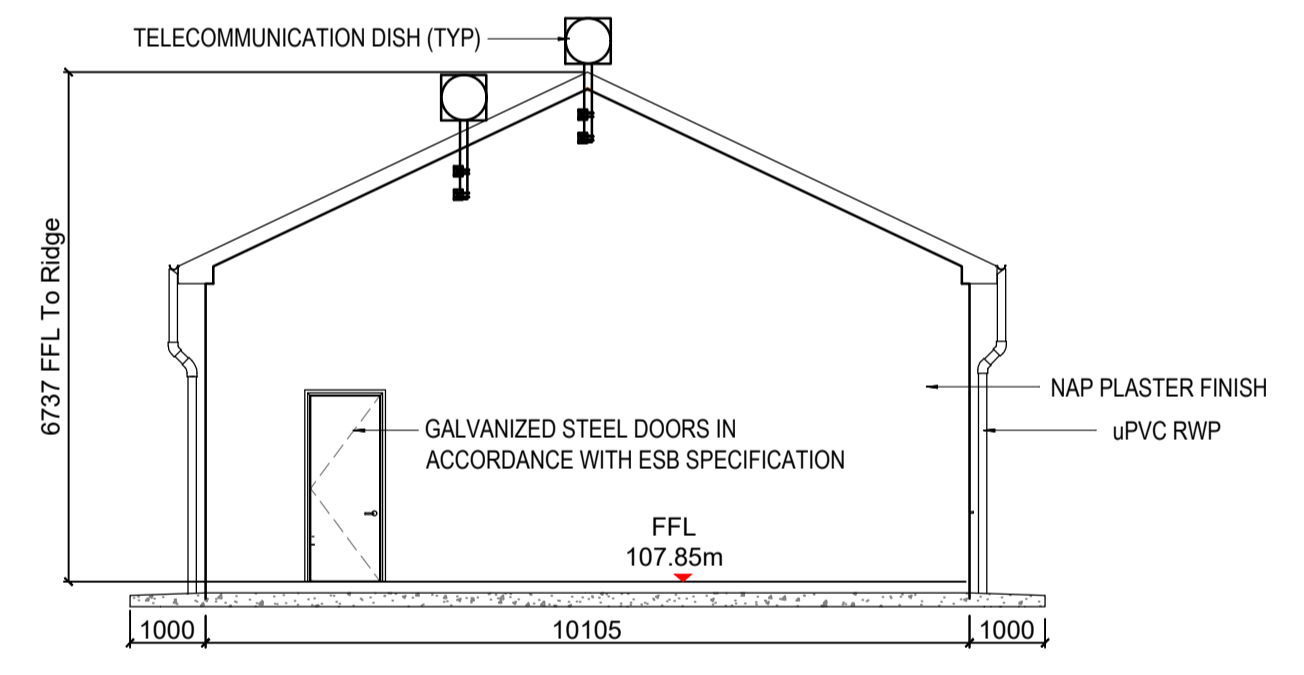


Side Elevation - North Scale 1:100

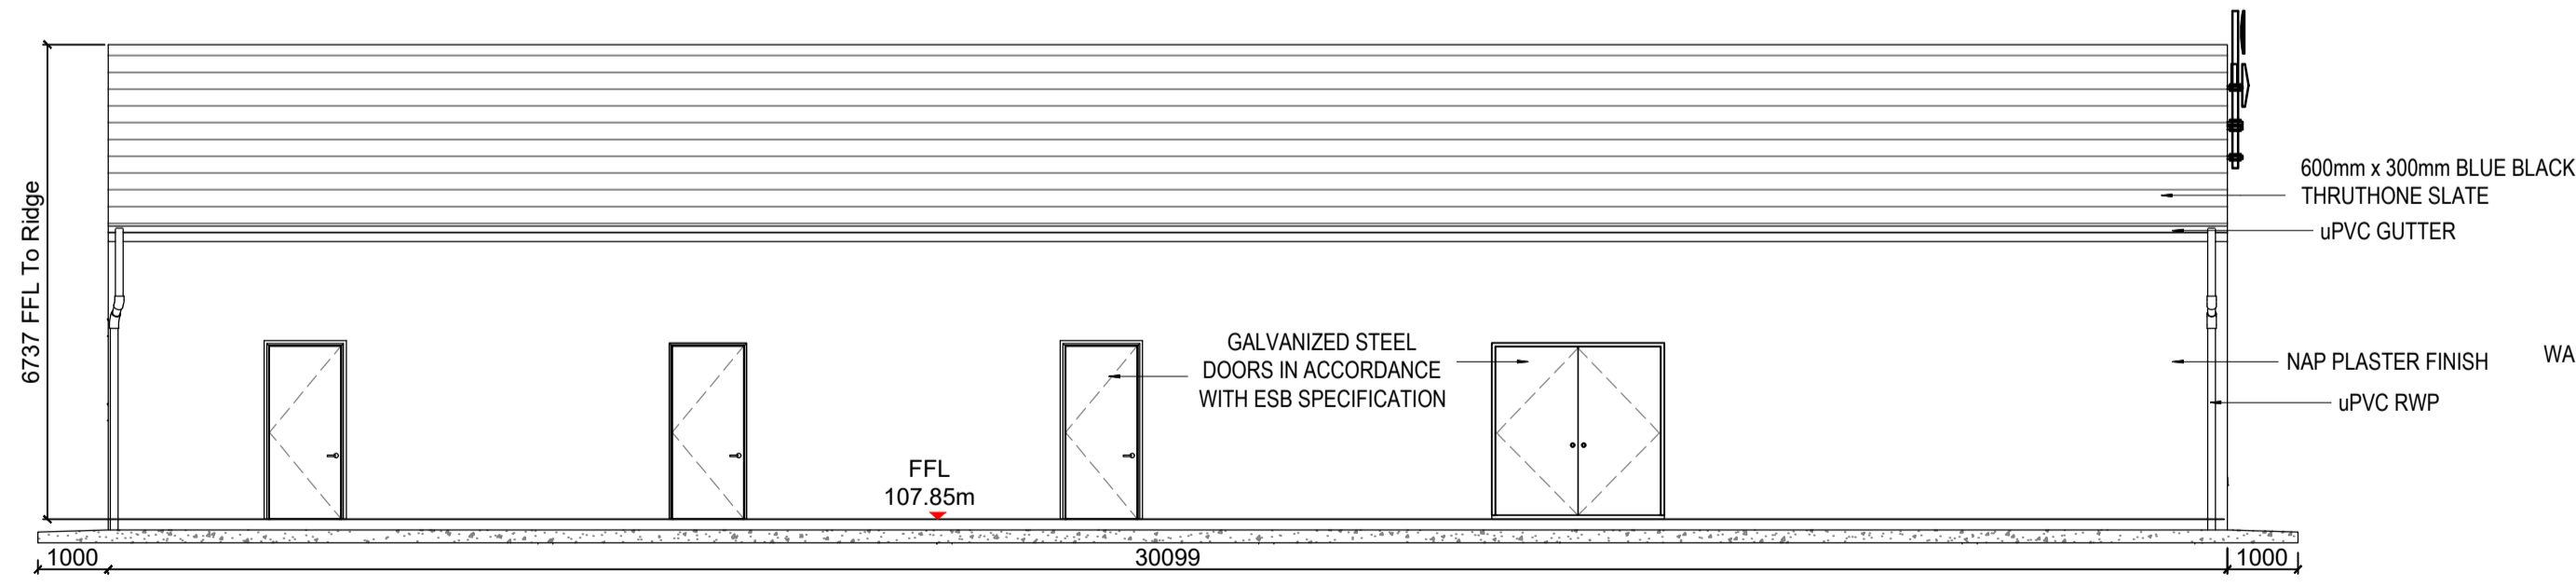

Rear Elevation - East Scale 1:100

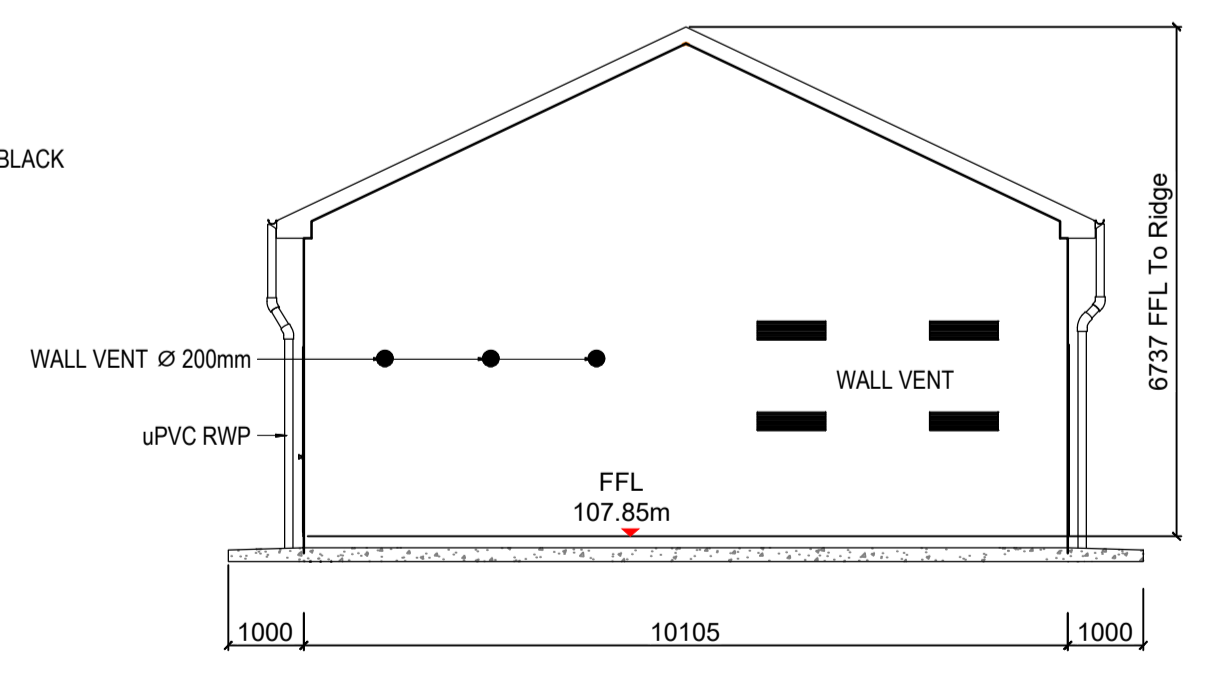

Side Elevation - South Scale 1:100

REV	DATE	DESCRIPTION	JK	PC
PROJECT: Brittas Wind Farm				
TITLE: IPP Building - Plan & Elevations & Section				
CLIENT: Brittas Wind Farm Ltd.				
 MWP ENGINEERING AND ENVIRONMENTAL CONSULTANTS CORK TRALEE LONDON LIMERICK mwp.ie				
DRAWN:	CHECKED:	APPROVED:		
JK	CMcL	PC		
PROJECT NUMBER:	DATE:	SCALE @ A1:		
23318	June 2024	1 : 100		
STATUS DESCRIPTION			STATUS:	
FOR INFORMATION			S2	
DRAWING NUMBER:				REV:
23318 - MWP - 00 - 00 - DR - C - 5422				P01